

<b>FLOOR</b>	<u>BASE</u>	<u>WALLS</u>	<u>CEILING</u>
A. EXISTING	A. 4" COVED	A. EXISTING	A. EXISTING LATEX
	VINYL		ENAMEL PAINT
B. VCT		B. LATEX ENAMEL	
	B. 6" COVED	PAINT	B. GYP. BD. LATEX
	VINYL		ENAMEL PAINT
		C. FRP PANELS	

#### REMARKS

1. NO PAINT REQ'D, THIS ROOM. T. B & T ONLY NEW GYP. BD WALLS. 2. 54" HIGH FRP PANEL WAINSCOT WITH TRIM AT PLUMBING WALL.


## CODE INFORMATION

REQUIRED PROVIDED 13 MEN: WATER CLOSETS ..... URINALS...

PLUMBING FIXTURE REQUIREMENTS PER IBC TABLE 2902.1


LAVATORIES 13 WOMEN: WATER CLOSETS .....


LAVATORIES ..

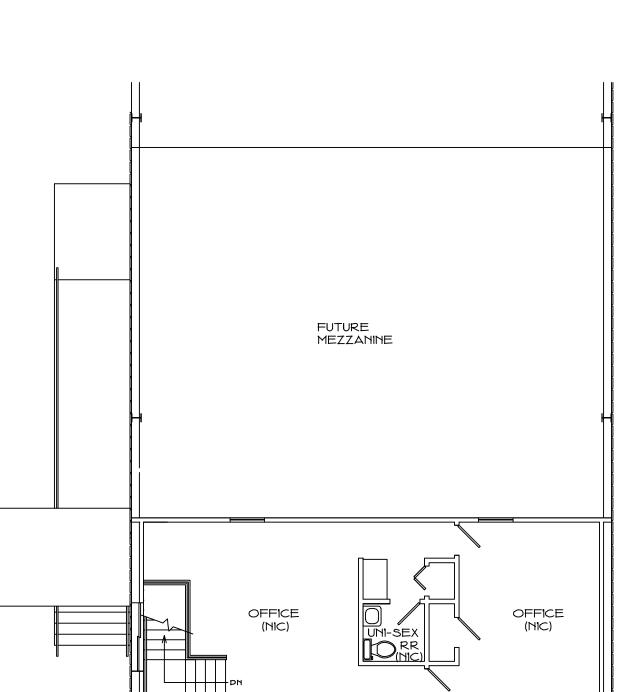

PARTIAL SECOND FLOOR PLAN

SC. 1/8"=1'-0"

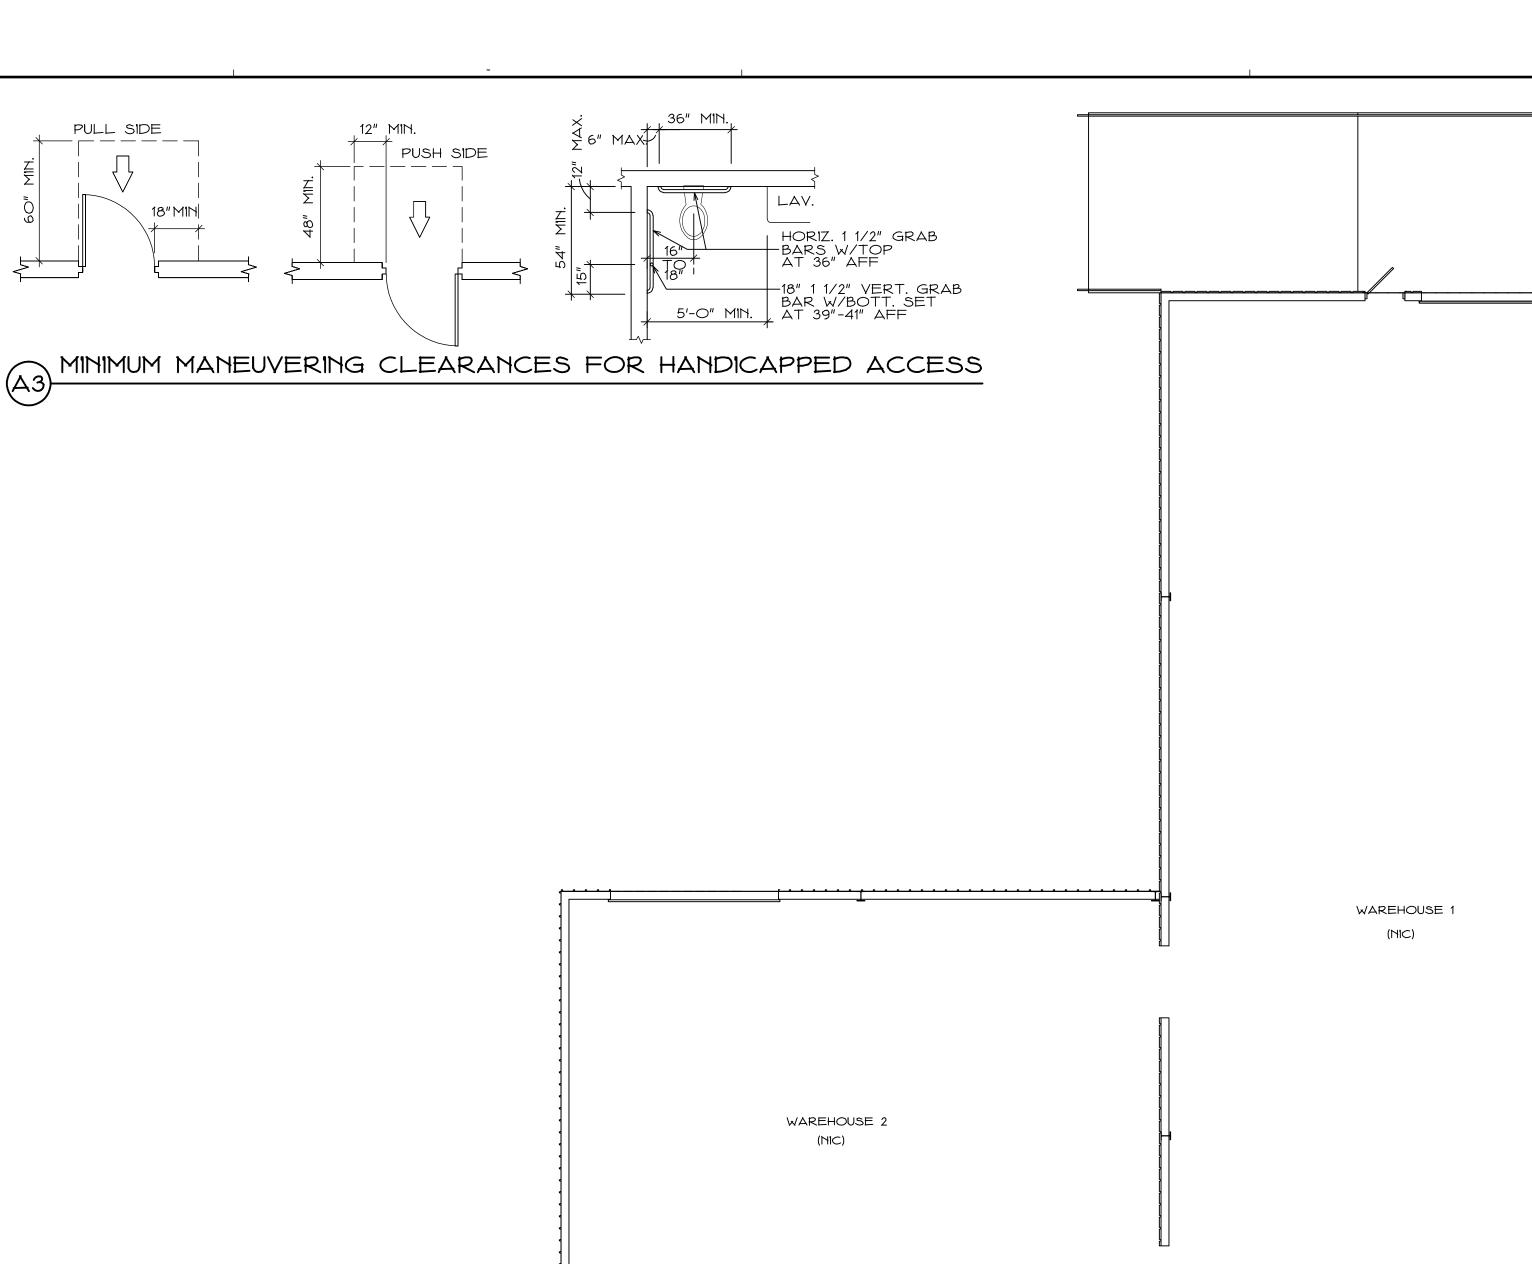

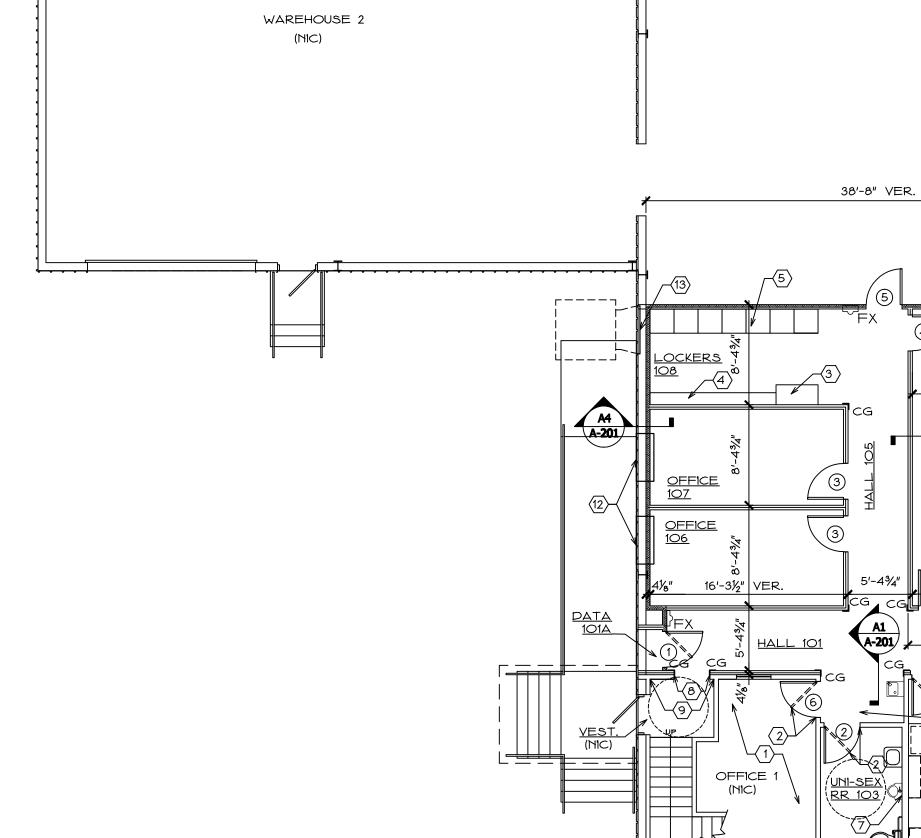

GROUND FLOOR PLAN

SC. 1/8"=1'-0"



EXIST. PRE-FIN. METAL "A" PANELS ON WALL GIRTS W/ NEW 2x4 STUDS AT 16" O.C. ON INTERIOR SIDE COVERED WITH 5/4 GYP. BD. W/6" (R-20) KRAFT-FACED BATT INSUL. IN STUDWALL CAVITIES

> =  $\frac{1}{2}$   $\frac{1}{2}$  GYP. BD. ON EACH SIDE OF  $\frac{1}{2}$   $\frac{1}{2}$ STUDS SPACED AT 16" O.C.

 $\sim$   $\frac{1}{2}$   $\frac{1}{2}$  STUDS SPACED AT 16" O.C. W/3 1/2" KRAFT-FACED BATT INSULATION

EXIST. PRE-ENG. BLDG. (P.E.B.) RIGID FRAME COLUMN- VERIFY ACTUAL SIZE & LOCATION IN THE FIELD

10. LB. FIRE EXTINGUISHER & CABINET

СĠ CORNER GUARD

## GENERAL NOTES

CONTRACTOR SHALL CAREFULLY EXAMINE ALL EXISTING CONDITIONS & SHALL IMMEDIATELY REPORT ANY QUESTIONABLE CONDITIONS TO THE ARCHITECT BEFORE PROCEEDING WITH THE WORK.

ALL CONSTRUCTION SHALL CONFORM TO THE LATEST ADOPTED EDITIONS OF THE IBC, IFC, UMC, NEC, NFPA, & ANS INCLUDING THEIR STATE OF N.M. EDITIONS FOR THESE CODES/STANDARDS.

ALL DIMENSIONS ARE TO FACE OF NEW DRY WALL PARTITIONS, EXT. FACE OF BUILDING, CENTER LINE AND/OR FACE OF BUILDING RIGID FRAME. ALL FLOOR PLAN DIMENSIONS ARE NOMINAL BASED ON 4¾" DRYWALL PARTITION THICKNESS. DIMENSIONS AT DOORS & FRAMES ARE ROUGH OPENING WIDTHS. ALL PLAN DIMENSIONS ARE NOMINAL.

OMISSIONS AND/OR CONFLICTS BETWEEN VARIOUS LEMENTS OF THE DRAWINGS, NOTES & DETAILS SHALL BE BROUGHT TO THE ATTENTION OF THE ARCHITECT & RESOLVED BEFORE PROCEEDING WITH THE WORK.

DO NOT USE SCALED DIMENSIONS. USE WRITTEN DIMENSIONS OR WHERE NO DIMENSION IS PROVIDED, CONSULT THE ARCHITECT BEFORE PROCEEDING WITH THE

ANY CHANGES MADE FROM THESE DRAWINGS SHALL BE MADE ONLY WITH THE ARCHITECT'S WRITTEN APPROVAL. OWNER & CONTRACTOR ASSUME FULL RESPONSIBILITY FOR ANY CHANGES MADE THAT ARE NOT APPROVED IN WRITING BY THE ARCHITECT.

ALL AREAS AFFECTED BY THE WORK SHALL BE FULLY PROTECTED DURING THE COURSE OF THE WORK. ANY DAMAGED SURFACES SHALL BE REPAIRED TO THE ARCHITECT'S & OWNERS APPROVAL.


ALL OPENINGS AROUND PIPES, CONDUITS, ETC. WHERE THEY PENETRATE ANY FIRE-RATED WALLS SHALL BE IN-FILLED WITH FIRE CODE WALL COMPOUND MATERIALS AS AS SPECIFIED.

OWNER SHALL STRIP EXIST. PAINT OFF FLOORS AT SPACES SCHEDULED TO RECEIVE NEW FLOORING & WILL GRIND DOWN SURFACE IRREGULARITIES BEFORE NEW FLOORING IS TO BE INSTALLED BY THE CONTRACTOR.

OWNERE WILL CLEAN OUT ALL DEBRIS FROM CRACKS IN FLOOR SLAB TO MIN. DEPTH OF 3" BEFORE FILLING CRACKS FULLY W/ ARDEX K-500 OR EQUIVALENT FLOOR PATCH WHERE NEW FLOORING IS SCHEDULED TO BE INSTALLED BY THE CONTRACTOR.

DRAWINGS INTEND TO MEET OR EXCEED BUILDING CODE STANDARDS BUT, IF ANY WORK INDICATED SHOULD BE SUBSTANDARD IN RELATION TO ANY ORDINANCES, LAWS, CODES, RULES OR REGULATIONS, THE GENERAL CONTRACTOR SHALL CONTACT THE ARCHITECT AND PER HIS DIRECTION, SHALL EXECUTE THE WORK CORRECTLY WITHOUT ANY ADDITIONAL PROJECT COST.

ALL WALL OR GIRT MOUNTED ITEMS IN WAREHOUSE 1 THA WILL INTERFERE WITH NEW WALL CONSTRUCTION SHALL BE REMOVED BY OWNER IN COORDINATION WITH THE CONTRACTOR.

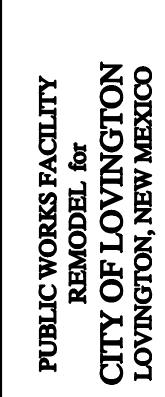

## KEYED NOTES

LOUNGE 109

OFFICE 2

- REMOVE EXISTING FLOOR COVERING AT THIS ROOM & INSTALL NEW VCT TILE FLOORING & 4" VINYL BASE AS PART OF ADD. ALTERNATE #2.
- EXISTING DOOR & FRAME TO BE REMOVED AND ROUGH OPENING TO BE PREPPED TO RECEIVE NEW DOOR, FRAME & HARDWARE AS SCHEDULED. 3. 20"D x 42"W WALL MOUNTED BENCH & FRAME. SEE
- C2/ A-2O1. 4. 12"D x 120"W WALL MOUNTED BENCH & FRAME. SEE
- C1/A-2O1. . 7-24" SQ. x 72"H LOCKERS WITH INTEGRAL 4" BASE.
- . 2 FLAT FILE CABINETS BY OWNER. REMOVE EXISTING FRP PANELS & GYP. BD. AS REQUIRED PROJECT NO: AT THIS WALL SO THAT EXISTING WALL URINAL CAN BE LOWERED ON THE WALL TO MEET ADA COMPLIANCE IN DRAWN BY: -COORDINATION WITH THE PLUMBING CONTRACTOR. . REMOVE EXISTING DOOR FRAME AND "CASE" THE OPG. W/ NEW GYP. BD. BEFORE T,B,T & P TO MATCH EXISTING.

TERMINATE NEW WALL PAINT AT THIS INSIDE CORNER. D. THIS SIDE OF DRYALL PARTITION TO BE BUILT TO FIT TIGHT AGAINST INSIDE FACE OF EXT. WALL PANELS. T,B,T & P ACCORDINGLY.

EXISTING WALL FAN TO BE REMOVED BY OWNER & OPG. INFILLED WITH WALL PANEL BY SAME. CREATE NEW OPENING THRU NEW & EXIST. WALL CONST FOR NEW THRU-WALL AC UNIT TO BE INSTALLED BY


MECH. CONTR. IN COORDINATION WITH GEN. CONTR. . EXISTING EVAP. COOLER GRILLE OPG. TO BE CAPPED BY OWNER.


SHEET TITLE FLOOR PLANS

DATE:


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## STUD NOTCHES AND HOLE DETAILS

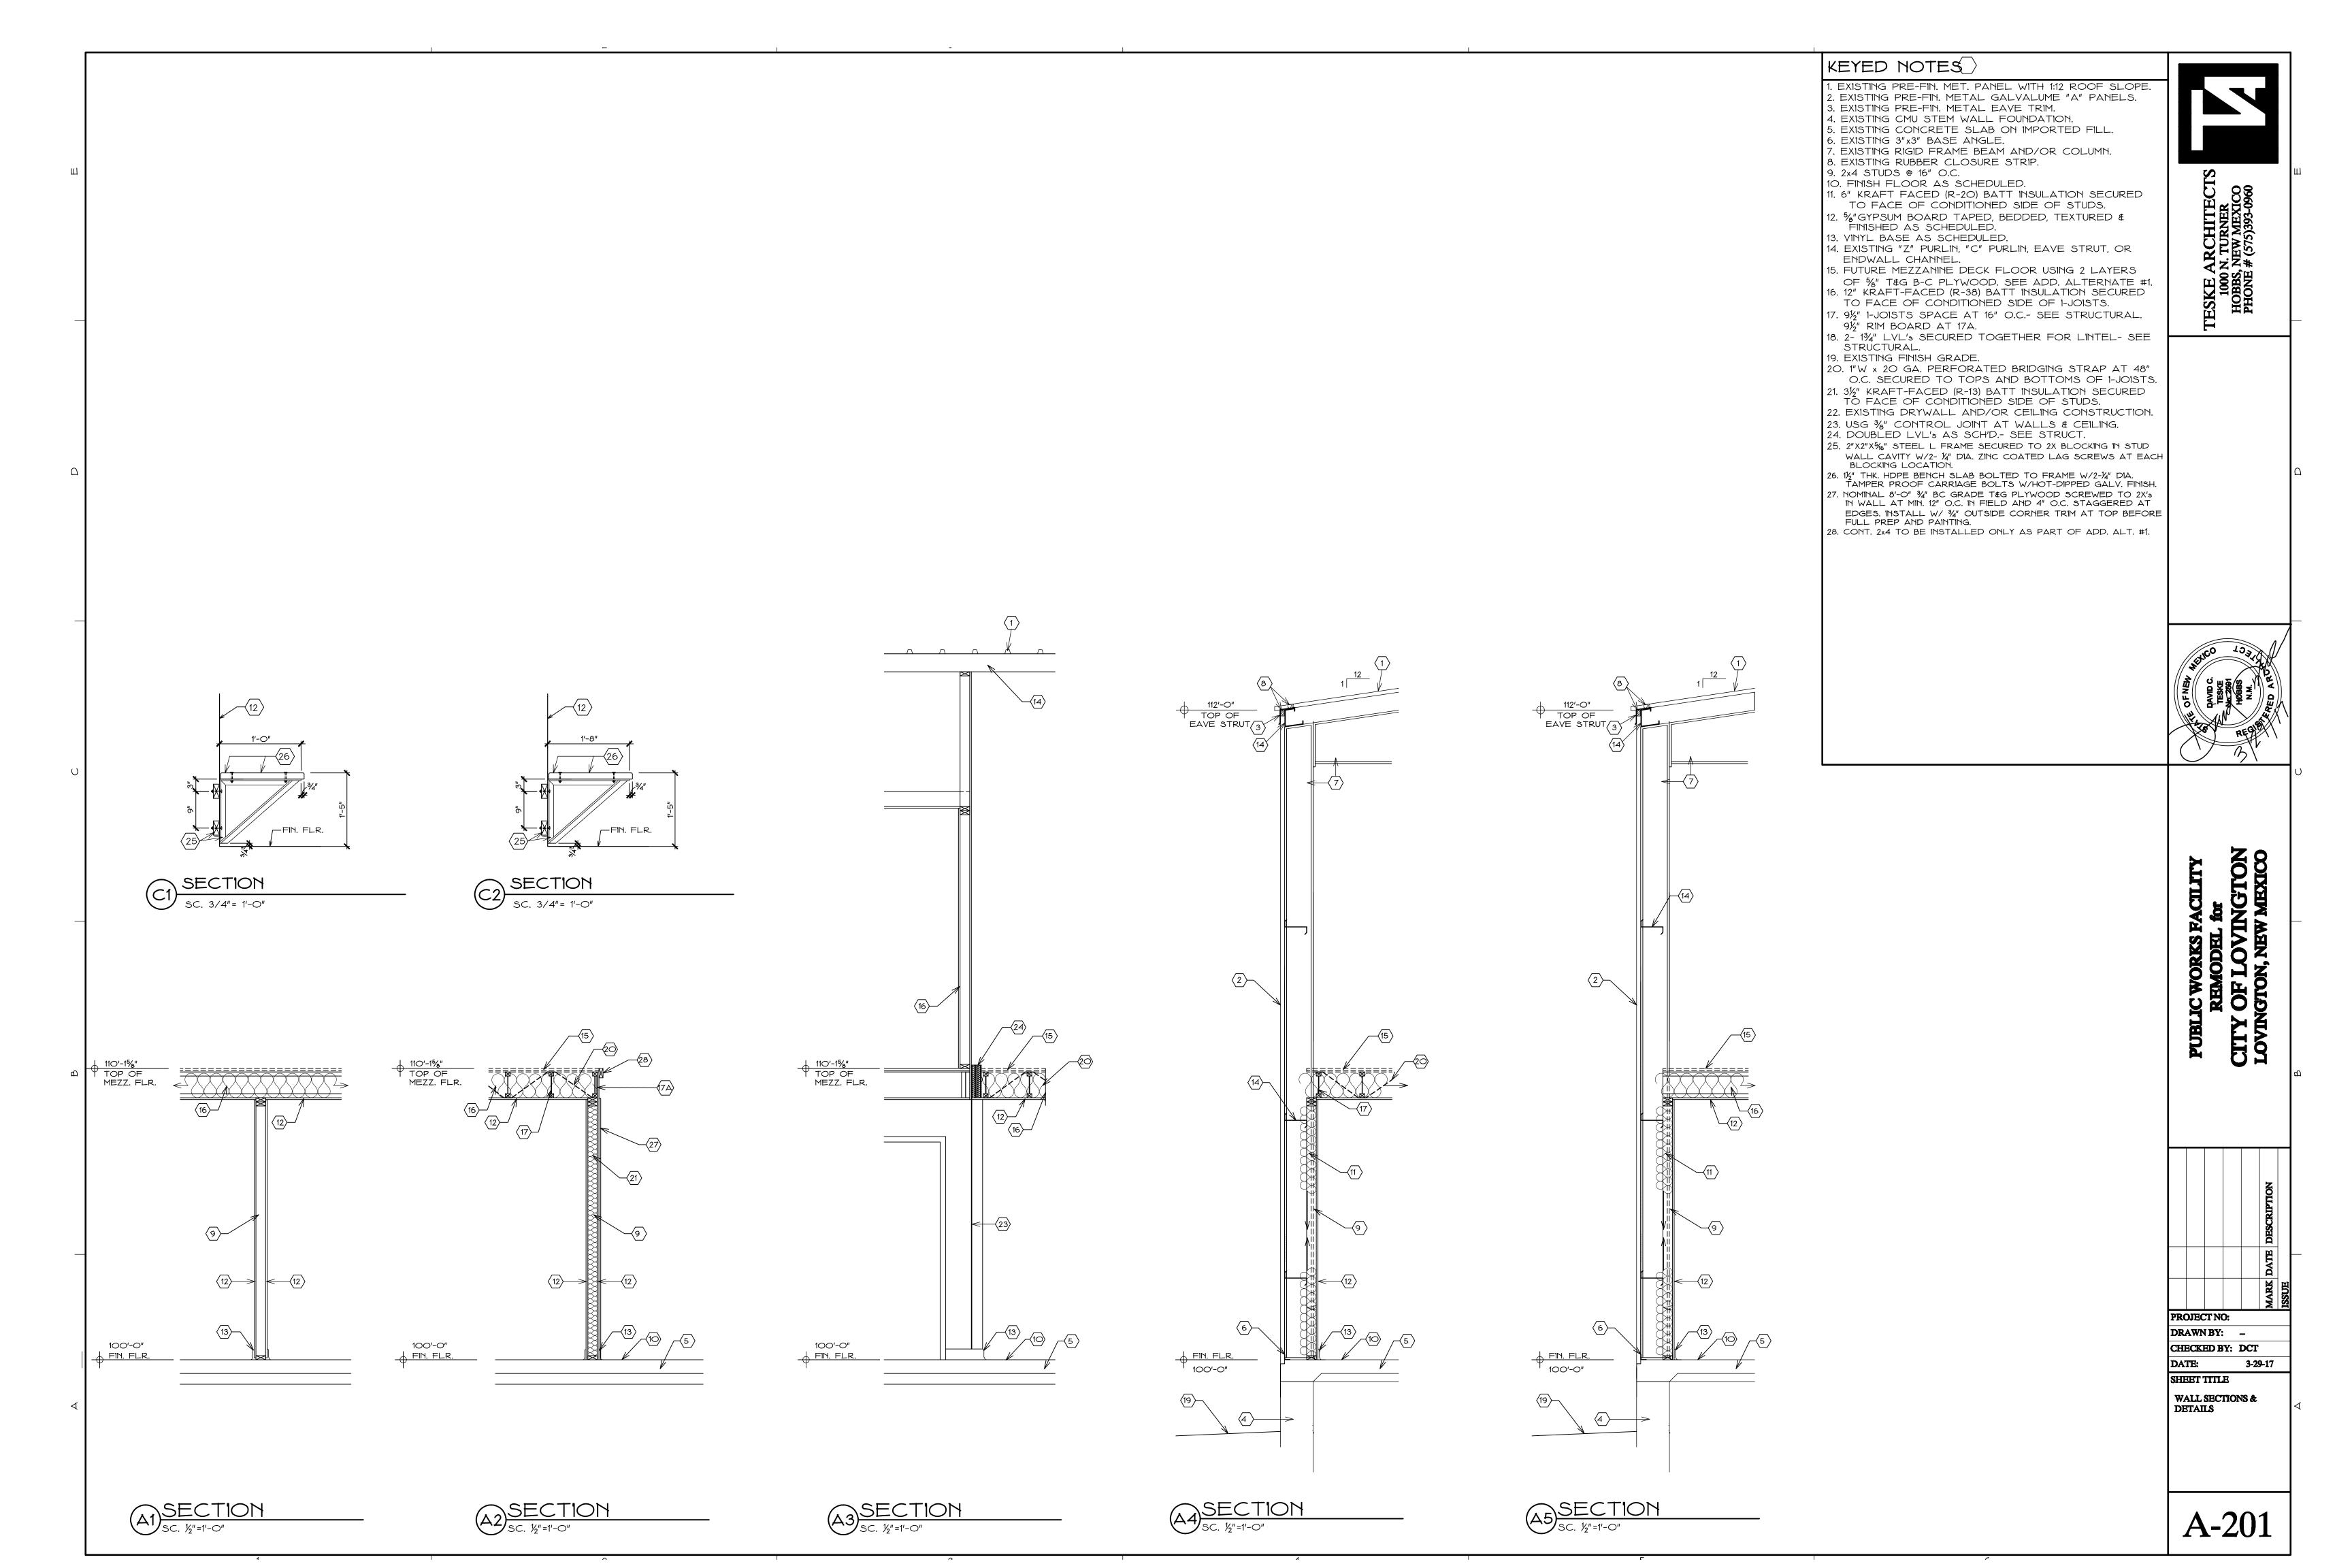

2 X 4 STUD

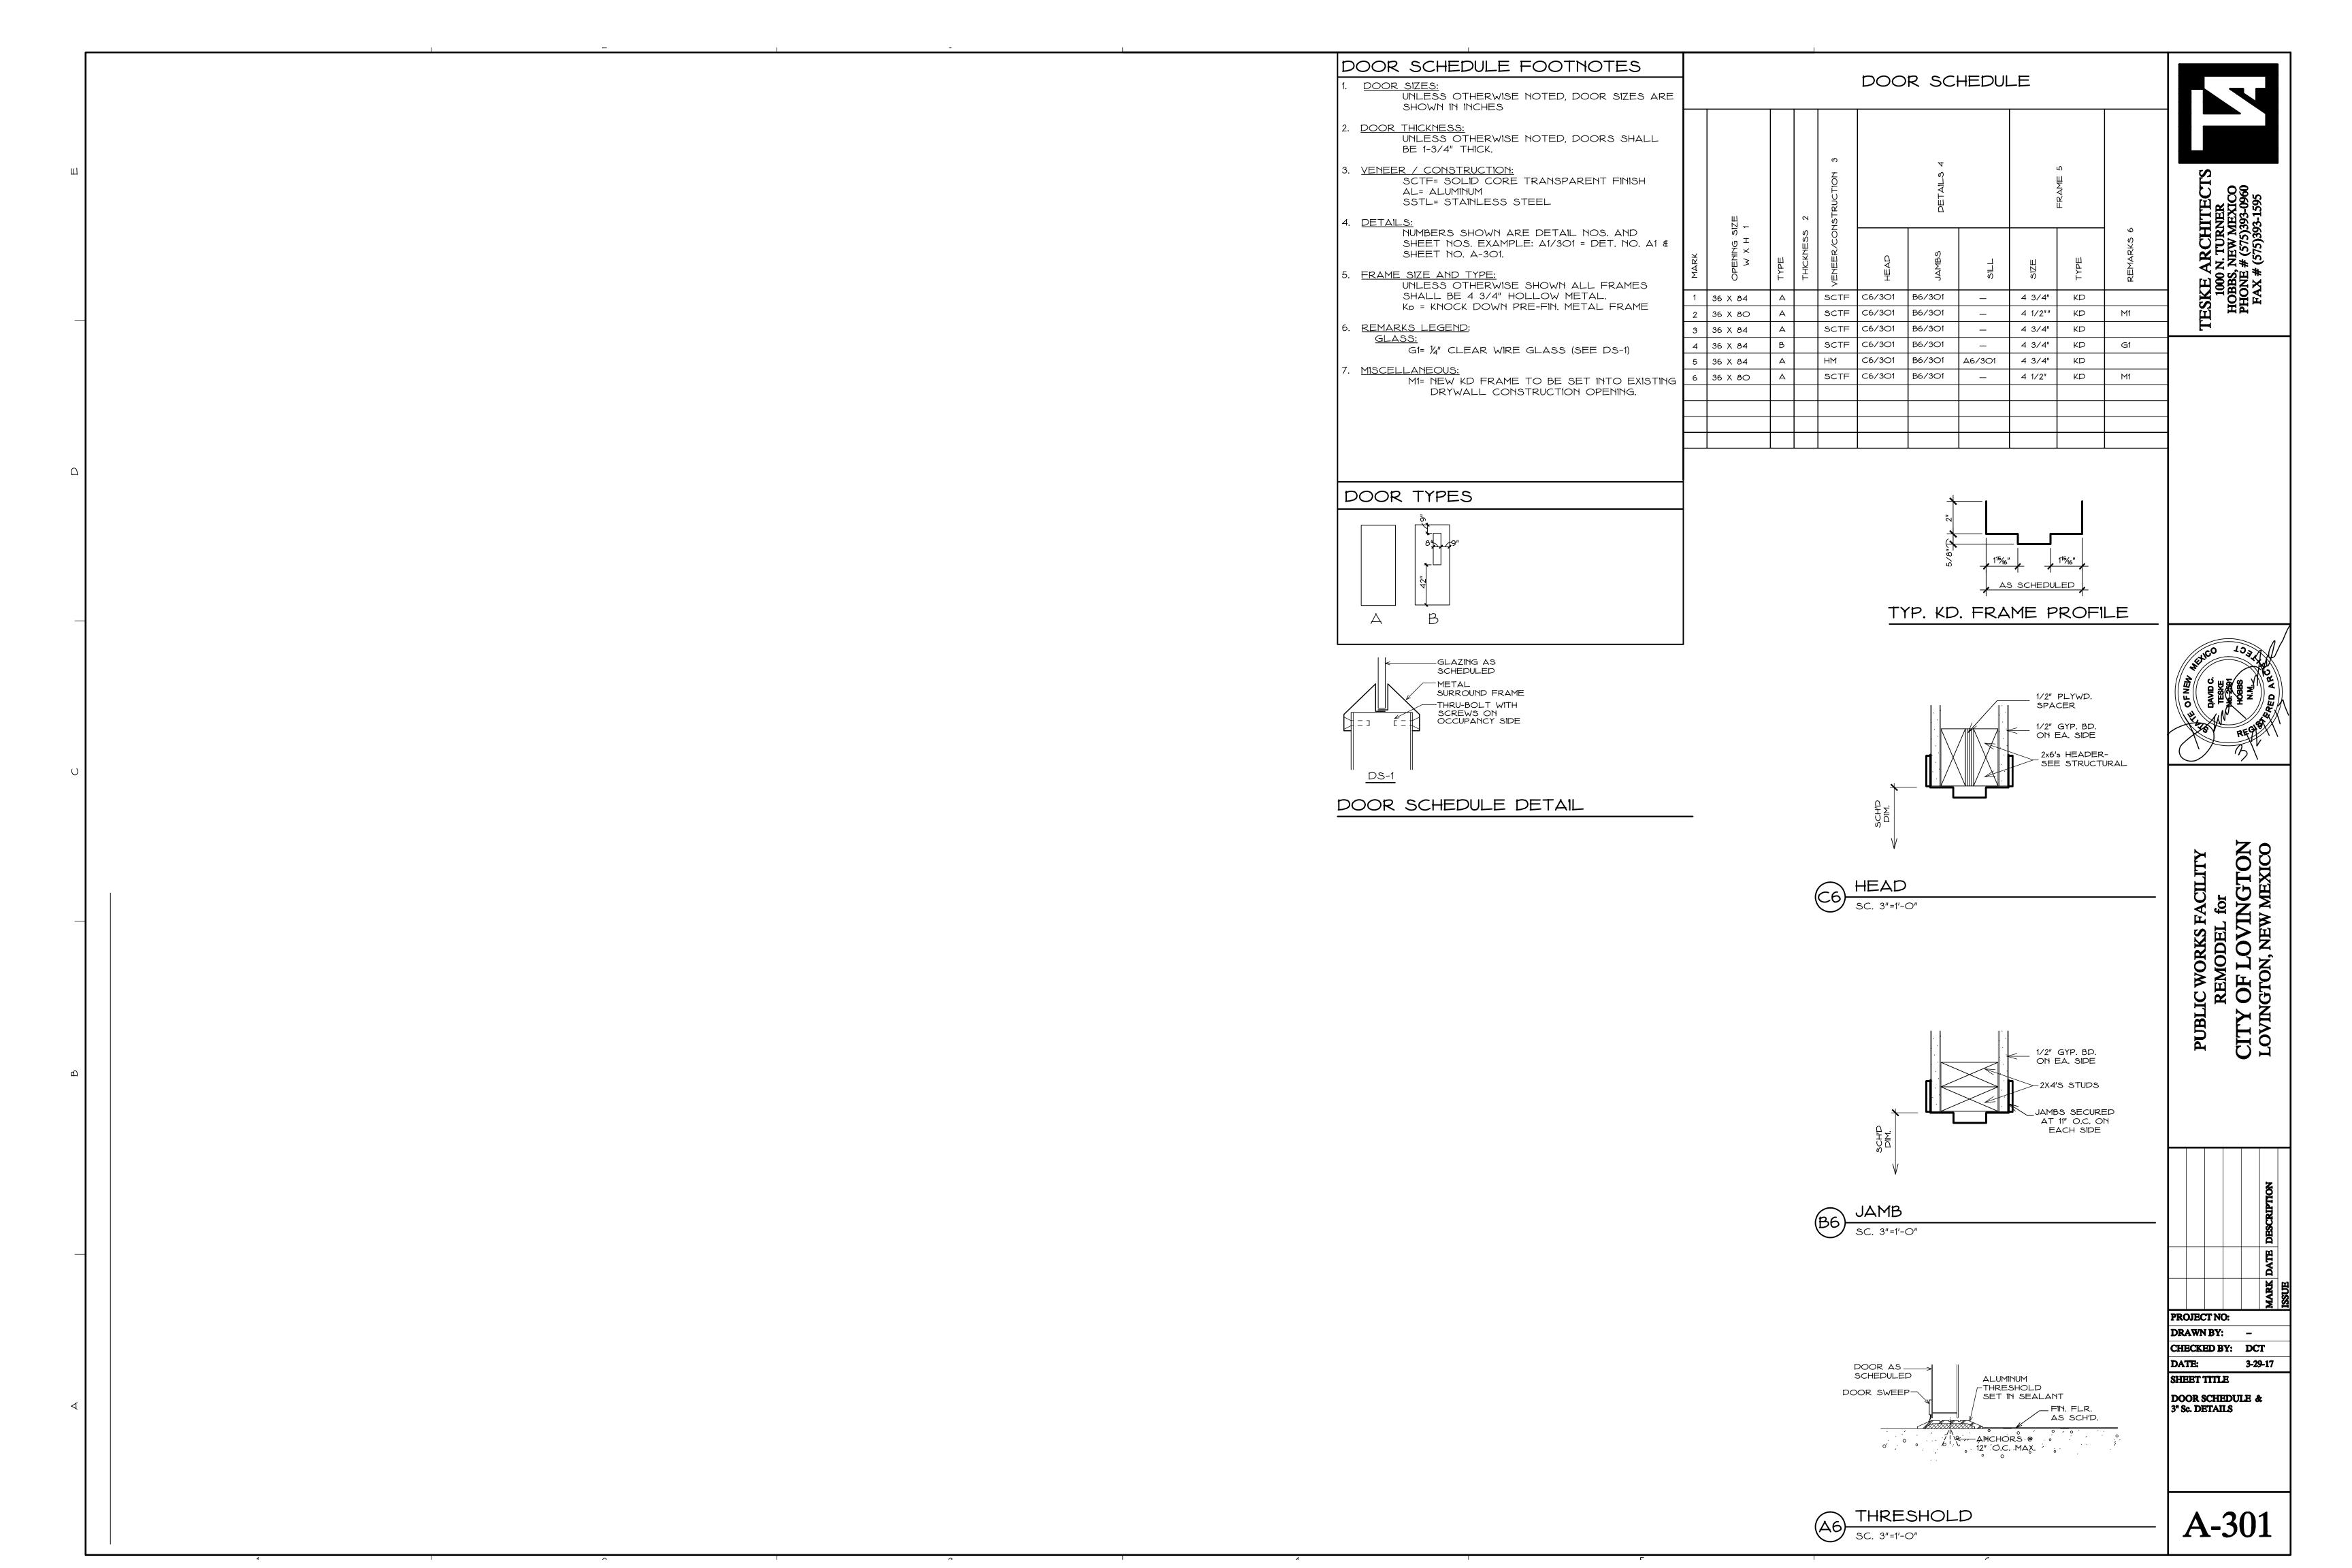
NOTCH DETAILS -

LOAD BEARING WALLS

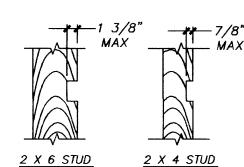
2 X 6 STUD

BORED HOLE DETAILS -LOAD BEARING WALLS


2 X 4 STUD

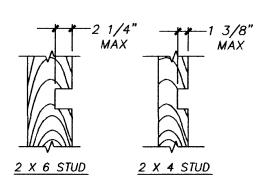


NOTCH DETAILS -NON-BEARING WALLS

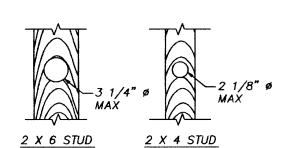

BORED HOLE DETAILS -NON-BEARING WALLS

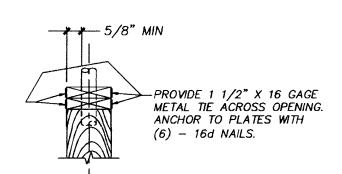

TOP PLATE AND SOLE PLATE PENETRATIONS

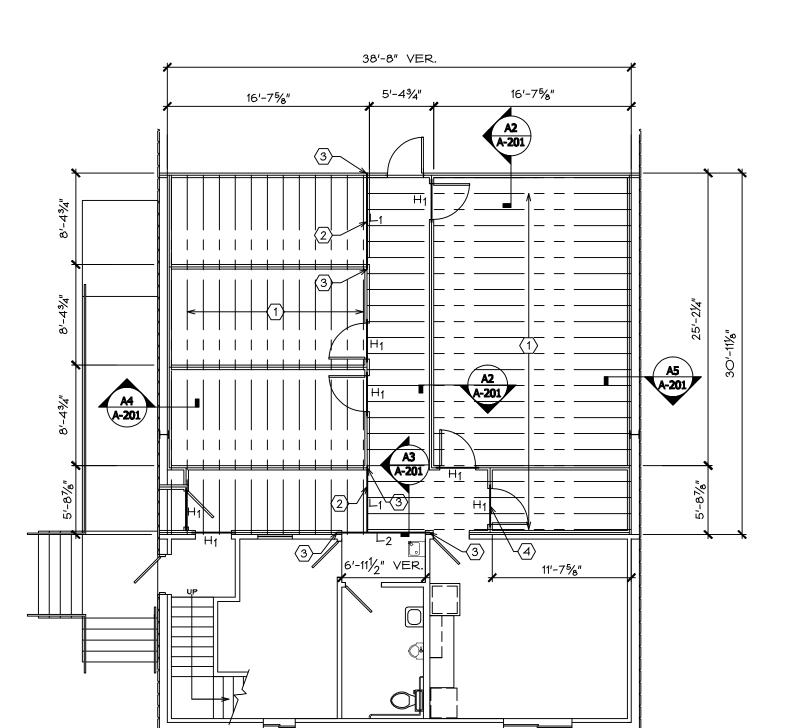


NAILING SCHEDULE

1. STUD TO SOLE PLATE .... 2. DOUBLE STUDS.... ...16D @ 3O" O.C. 3. TOP PL. SPIKE TOGETHER .... ....16D @ 24" O.C. 4. TOP PL. TO STUD ... ....3-16D 5. HEADER TO STUD... 6. ALL OTHER NAILING SHALL BE PER IBC TABLE 2304.9.1 UNLESS OTHERWISE NOTED.

2-2X6's W/½" \_CONT. 24/O EXT.

PLYWD. NAILED

W/16D NAILS

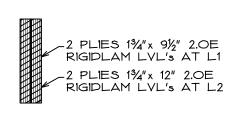

∟<sub>1</sub> ∉ ∟<sub>2</sub>

LINTEL & HEADER SCHEDULE

MEZZANINE FLOOR/CEILING JOISTS FRAMING PLAN Sc. 1/8"=1'-0"



#### GENERAL STRUCTURAL NOTES

LIVE LOADS: DEAD LOADS:

40 PSF

20 PSF TIMBER AND WOOD STUD FRAMING FRAMING LUMBER SHALL COMPLY WITH THE LATEST EDITION OF THE GRADING RULES OF THE WESTERN WOOD PRODUCTS ASSOCIATION OR THE WEST COAST LUMBER INSPECTION BUREAU. ALL SAWN LUMBER SHALL BE STAMPED WITH THE GRADE MARK

ETC. SHALL HAVE THE FOLLOWING MINIMUM PROPERTIES: STUDS/ FB FV E Fc WOOD FRAMING (PSI) (PSI) (PSI) (PSI) TYPE 1450 (REP) 95 1,700,000 N/A D.F. #2 2X4 £ 2X6 1250 (SING) 95 1,700,000 N/A D.F. #2 HEADERS & SILL/TOP PLATES

OF AN APPROVED LUMBER GRADING AGENCY. STUDS, HEADERS,

- . ALL FRAMING MEMBERS SHALL BE OF SIZE AS SHOWN ON THE DRAWINGS. GRADE SHALL BE #2 YELLOW PINE, #2 HEM-FIR. USE #2 CEDER OR DOUG FIR. AT FLOOR LOCATIONS SILL PLATES SHALL BE PRESSURE TREATED WITH WOOD PRESERVATIVE.
- S. ALL MEMBERS SHOWN AS HEADERS & COMPOSITE WOOD BEAM LINTELS SHALL BE GLUED & NAILED W/16D NAILS STAGGERED AT 12" O.C. EACH SIDE.
- I. ALL FLOOR DECKING SHALL BE APA RATED, EXPOSURE 1 WITH EXTERIOR GLUE AND SHALL BEAR THE STAMP OF AN APPROVED TESTING AGENCY. STAGGER JOINTS. ALL NAILING TO BE COMMON NAILS. ALL DECKING SHALL BE OF THE FOLLOWING NOMINAL THICKNESS, SPAN/INDEX RATIO AND SHALL BE NAILED AS FOLLOWS UNLESS NOTED OTHERWISE:

EDGE INTERMEDIATE SPAN/INDEX THICKNESS NAILING NAILING HEAD FLOOR %" 24/0 8D @ 6" O.C. 8D @ 12" O.C. 8D @ 4" O.C. 8D @ 8" O.C.

- . BRIDGING UNLESS COVERED BY INTERIOR OR EXTERIOR WALL COVERINGS OR SHEATHING MEETING THE MINIMUM REQUIREMENTS OF THE CODE, ALL STUD PARTITIONS/ WALLS OF 6' OR HIGHER SHALL HAVE BRIDGING NOT LESS THAN 2 INCHES IN THICKNESS AND OF THE SAME WIDTH AS THE STUDS FITTED SNUGLY AND NAILED THERETO TO PROVIDE ADEQUATE LATERAL SUPPORT.
- 5. CUTTING AND NOTCHING ANY EXTERIOR OR BEARING WOOD STUD WALL MAY BE CUT OR NOTCHED TO A DEPTH NOT EXCEEDING 25 PERCENT OF ITS OVERALL WIDTH.
- BORED HOLES NOT GREATER IN DIAMETER THAN 40 PERCENT OF THE STUD WIDTH MAY BE BORED IN ANY WOOD STUD. IN NO CASE SHALL THE EDGE OF THE BORED HOLE BE NEARER THAN 1/2 INCH TO THE EDGE OF THE STUD. BORED HOLES SHALL NOT BE LOCATED AT THE SAME SECTION OF STUD AS A CUT OR NOTCH IN THE STUD. SEE STUD NOTCH/BORING DETAILS THIS SHEET.
- 3. ALL PLAN DIMENSIONS ARE TAKEN FROM FACE OF STUDWALLS.
- 9. ALL FLOOR/CEILING JOISTS SHALL BE 9½" 1-JOISTS UNLESS NOTED OTHERWISE . ALL JOISTS SHALL BE SPACED AT 16" O.C. UNLESS NOTED OTHERWISE.
- 10. TOP PLATE OF STUD WALLS SHALL BE 8'-1%" AFF UNLESS NOTED OTHERWISE, BEARING ELEV. FOR ALL LINTELS TO BE 8'-1/8" UNLESS NOTED OTHERWISE.

LVL & 1-JOIST MEMBERS

MANUFACTURER OF ALL LVL & 1-JOIST MEMBERS SHALL BE BY ROSEBURG FOREST PRODUCTS OR EQUIVALENT MANUFACTURER.

- . ALL LVL MEMBER HEADERS SHALL BEAR FULLY ON MINIMUM OF ONE STUD MEMBER & ALL LVL MEMBER LINTELS SHALL BEAR FULLY ON MINIMUM OF TWO STUD MEMBERS.
- ALL LVL MEMBERS SHALL BE 1.8 E GRADE OF WHICH SHALL BE CLEARLY STAMPED ON EACH MEMBER ALONG WITH MEMBER'S
- I. ALL 1-JOIST MEMBERS SHALL BE RFP1 40 (PR1 40) GRADE OF WHICH SHALL BE CLEARLY STAMPED ON EACH MEMBER ALONG WITH MEMBER'S DEPTH.
- . ALL MEMBERS SHALL BE STORED, HANDLED, ERECTED, INSTALLED AND BRACED PER MANUFACTURE'S MINIMUM REQUIREMENTS.
- ANY DAMAGED MEMBERS SHALL NOT BE INSTALLED WITHOUT CONFERRING WITH THE MANUFACTURER FIRST. ULTIMATE LIABILITY FOR USING ANY DAMAGED MEMBERS RESTS SOLELY WITH THE INSTALLING CONTRACTOR.
- NEED FOR FIELD CUTTING OR KNOCK-OUT OF ANY HOLES THRU WEB OF ANY 1-JOST MEMEBER SHALL BE APPROVED BY 1-JOIST MANUFACTURER & COORDINATED WITH ARCHITECT PRIOR TO BEING DONE IN THE FIELD & PENETRATIONS SHALL BE MADE IN STRICT ACCORDANCE WITH 1-JOISTS MFGR'S. WEB HOLE CUTTING SPECIFICATIONS.

<u>'LYWOOD/OSB</u>

- FLOOR PLYWOOD SHALL BE 56" STANDARD T&G CDX APA RATED SHEATHING (4-PLY) WITH STAMP OF APPROVED TESTING AGENCY.
- . OSB SHEATHING CAN BE USED IN LIEU OF PLYWOOD (UNLESS IT IS SPECIFICALLY NOTED OTHERWISE) AS LONG AS IT MEETS SAME CRITERIA AND WITH STAMP OF AN APPROVED TESTING AGENCY.

PUBLIC WORKS FACILITY
REMODEL for
CITY OF LOVINGTON
LOVINGTON, NEW MEXICO

KEYED NOTES

TYPICAL 91/2" I-JOIST CEILING/FLOOR JOISTS FRAMING AT 16" O.C. BELOW (NOT SHOWN) ARE AT 24" O.C. NOTE THAT CEILING/SOFFI JOISTS CAN RUN PARALLEL OR PERPENDICULAR TO RAFTERS. . TYPICAL DOUBLED 9½" LVL'S LINTEL AS SCHEDULED. B. EACH LINTEL TO FULLY REST ON MINIMUM OF 2 JOINED STUDS SET

IN STUD WALL CAVITY. . TYPICAL DOUBLED 2x's HEADER AS SCHEDULED.

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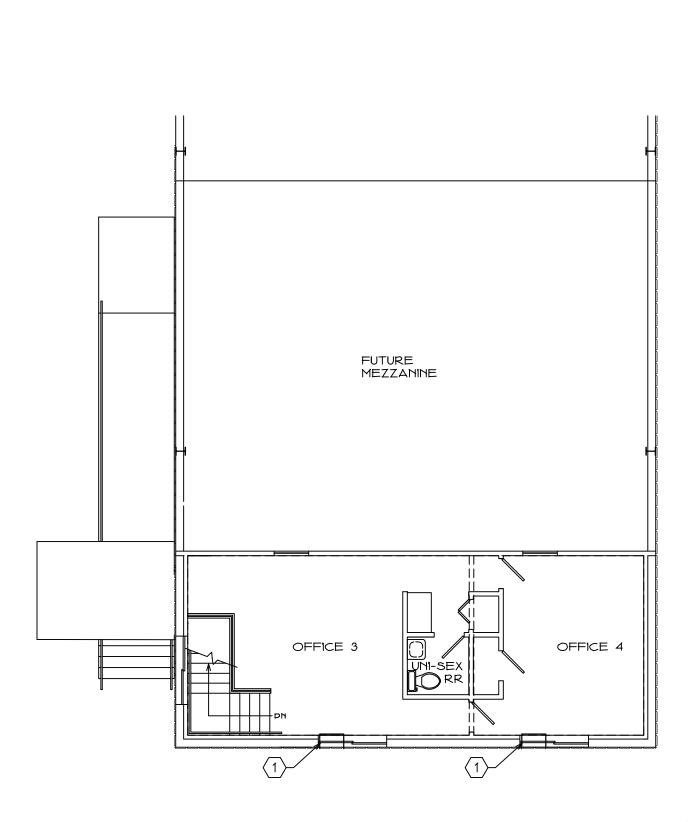
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SHEET TITLE

MEZZANINE FLOOR FRAMING PLAN & SCHEDULES


3-29-17

	HVAC EQUIPMENT SCHEDULE
ITEM	DESCRIPTION
TWU-1	AMANA PTH153G5OAXX THRU-WALL AC UNIT RATED AT 14,200 BTU COOLING & 13,800 BTU HEATING WITH 5.0 KW HEAT STRIP. 230/208 VOLTS. 9.7 EER. INSTALL UNIT W/ AGK10CB EXTERIOR GRILLE, WS900E INSULATED WALL SLEEVE, DK900D CONDEN. DRAIN KIT & 2246008 PROGRAMMABLE T-STAT. INSTALL FOAM WEATHER SEAL AT EXT. OF UNIT TO MAKE ENTIRE INSTALLATION WATER TIGHT. MOUNT W/ TOP OF UNIT AT 80" AFF.
TWU-2	AMANA PTHO93G35AXXX THRU-WALL AC UNIT RATED AT 9,000 BTU COOLING & 8,000 BTU HEATING WITH HEAT BACK UP. 230/208 VOLTS. 11.5 EER. INSTALL UNIT W/ AGK10CB EXTERIOR GRILLE, WS900E INSULATED WALL SLEEVE, DK900D CONDEN. DRAIN KIT& 2246008 PROGRAMMABLE T-STAT. INSTALL FOAM WEATHER SEAL AT EXT. OF UNIT TO MAKE ENTIRE INSTALLATION WATER TIGHT. MOUNT W/ TOP OF UNIT AT 80" AFF.



PARTIAL MECH. SECOND FLOOR PLAN

SC. 1/8"=1'-0"

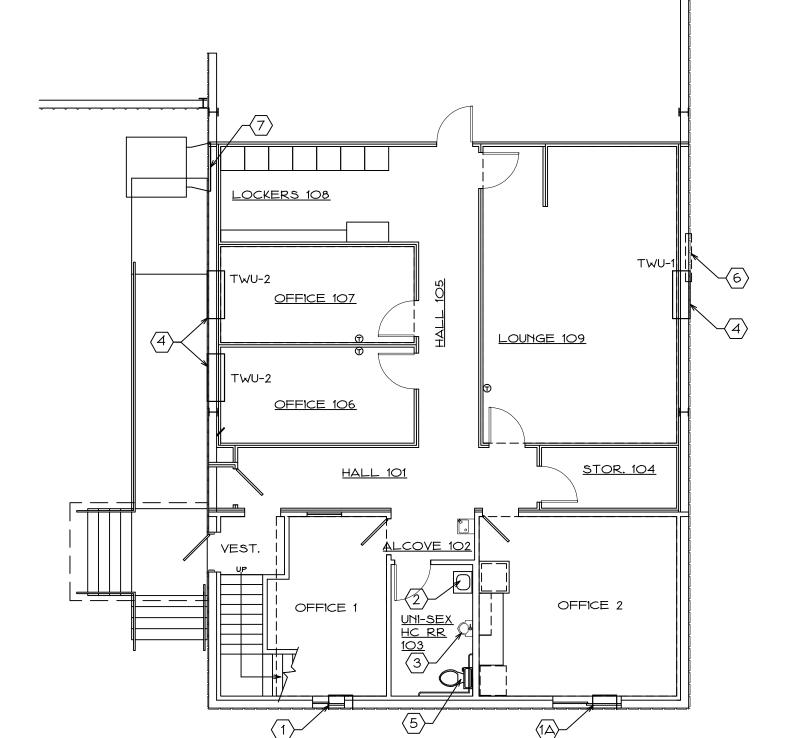

PARATIAL MECH. & PLUMBING FLOOR PLAN



### PLANS LEGEND

THRU-WALL PTAC UNIT TO BE MOUNTED WITH TOP SET AT 80" AFF




#### GENERAL NOTES

ALL WORK SHALL BE PER LATEST UNIFORM MECHANICAL CODE, UNIFORM PLUMBING CODE AND THEIR STATE ADOPTED EDITIONS.

MECHANICAL CONTRACTOR SHALL COORDINATE HIS WORK WITH THE ELECTRICAL CONTRACTOR AS NEEDED TO AVOID ANY POSSIBLE CONFLICTS.

CONTRACTORS SHALL CAREFULLY EXAMINE ALL BUILT CONDITIONS AND SHALL IMMEDIATELY REPORT ANY QUESTIONABLE CONDITIONS TO THE ARCHITECT & JOB SUPERINTENDENT BEFORE PROCEEDING WITH THE WORK.

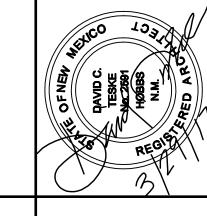

#### KEYED NOTES (

1. EXISTING THRU-WALL HVAC UNIT TO BE REMOVED & REPLACED BY OWNER. EXISTING UNIT TO REMAIN IN PLACE AT 1A.

. EXISTING LAVATORY & CABINET TO REMAIN IN PLACE. . EXISTING URINAL TO BE REMOVED & REINSTALLED ON WALL WITH A

3. EXISTING URINAL TO BE REMOVED & REINSTALLED ON WALL WITH A NEW RIM HGT. OF 17". INSTALL NEW FITTINGS & PIPE AS REQUIRED.

4. NEW THRU-WALL HVAC UNIT AS SCHEDULED TO BE INSTALLED IN NEW OPENING MADE THRU NEW & EXISTING WALL IN COORDINATION WITH THE GENERAL CONTRACTOR.


5. EXISTING WATER CLOSET TO BE REMOVED & SALVAGTED FOR THE OWNER. INSTALL NEW HC COMPLIANT WATER CLOSET EQUIVALENT TO KOHLER HIGHLINE K-3519 WATER CLOSET.

EXISTING WALL FAN TO BE REMOVED BY OWNER & POWER TO FAN

TERMINATED BY SAME.

7. EXISTING EVAP COOLER GRILLE OPENING TO BE BLANKED-OFF WITH

20 GA. GALV. BROKE SHEET METAL BY OWNER & SEALED TIGHT.

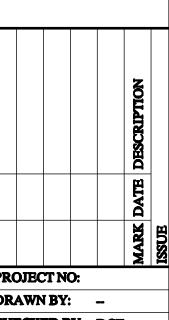


PROJECT NO: DRAWN BY: -CHECKED BY: DCT DATE: 3-29-17

SHEET TITLE PARTIAL MECHANICAL & PLUMBING FLOOR PLANS

MP-101

SC. 1/8"=1'-0"

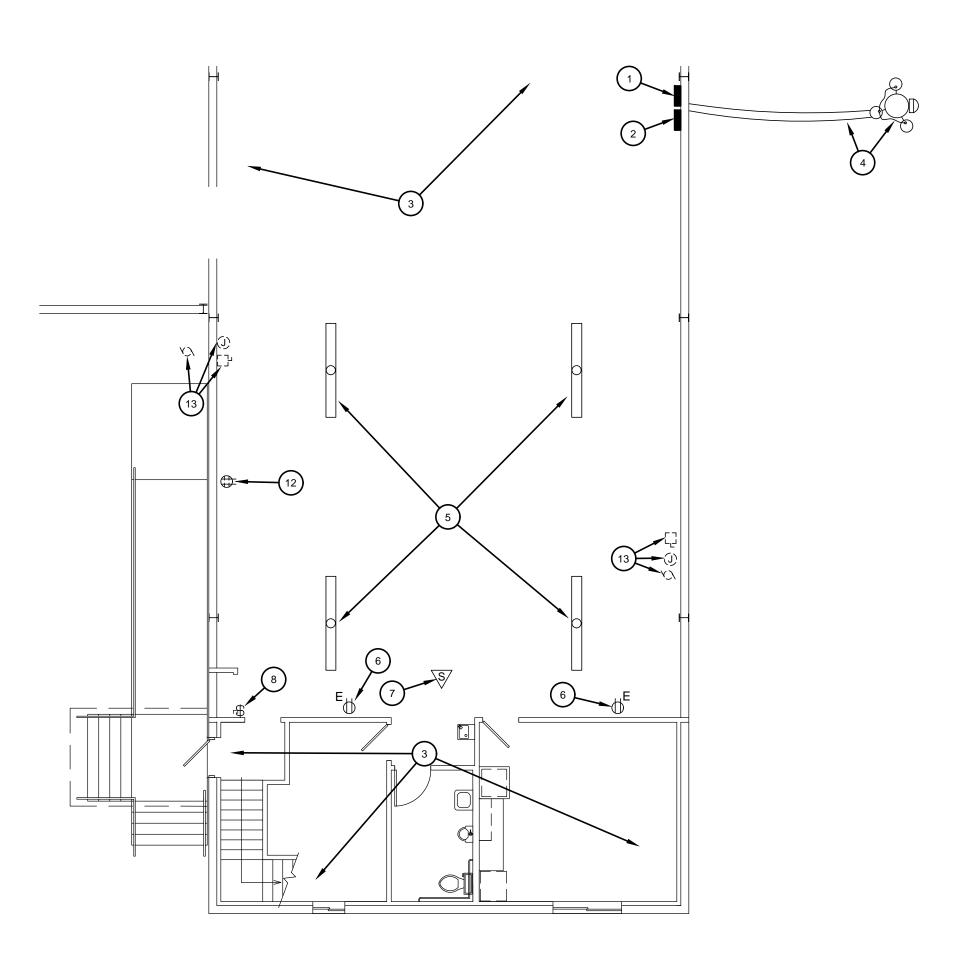




## GENERAL NOTES:

- A. VERIFY EXACT LIGHT FIXTURE LOCATIONS WITH ARCHITECTURAL REFLECTED CEILING PLAN.
- B. WALL BOX LIGHT SWITCH OCCUPANCY (MOTION) SENSORS SHALL BE EQUAL TO WATT-STOPPER NO. DW-100.
- C. IT IS ASSUMED THAT ANY OUTLET, SWITCH, RECEPTACLE, FIXTURE OR PANEL MAY BE RELOCATED WITHIN A TEN (10) FOOT RADIUS OF THE INDICATED LOCATION WITHOUT ADDITIONAL CHARGE
- D. CONTRACTOR SHALL VERIFY EXISTING CONDITIONS BEFORE BIDDING TO DETERMINE THE TOTAL SCOPE OF WORK REQUIRED AND INCLUDE ALL IN BID.
- E. ALL ABOVE CEILING CABLING SHALL BE SEPARATED BY TYPE, BUNDLED NEATLY AND SUPPORTED BY J-HOOKS FROM
- F. VERIFY EXACT LOCATION OF ALL WALL, FLOOR AND CEILING MOUNTED DEVICES AND EQUIPMENT WITH THE ARCHITECT. VERIFY EXACT MOUNTING HEIGHTS OF ALL RECEPTACLES WITH ARCHITECT PRIOR TO ROUGH-IN.
- G. ELECTRICAL DEVICE INSTALLATION SHALL COMPLY WITH ACCESSIBILITY CODES ADOPTED FOR STATE OF NEW MEXICO.
- H. COORDINATE ALL RECEPTACLE, COMMUNICATION OUTLETS AND J-BOX LOCATIONS WITH ARCHITECTURAL WALL
- ELEVATIONS TO AVOID SHELVING, MILLWORK, ETC.

  I. VERIFY EXACT MOUNTING HEIGHT OF ALL RECEPTACLES, COMMUNICATION OUTLETS AND J-BOXES SHOWN ABOVE OR BELOW MILLWORK, CABINETS, TABLES, ETC. WITH ARCHITECT PRIOR TO ROUGH-IN.
- J. CONTRACTOR SHALL PROVIDE COMMUNICATION OUTLET AND CONDUIT ROUGH-INS AS DIRECTED BY OWNER.
- K. VERIFY EXACT MECHANICAL EQUIPMENT, THERMOSTAT AND SENSOR LOCATIONS WITH MECHANICAL PLANS. PROVIDE A J-BOX AT ALL THERMOSTAT AND SENSOR LOCATIONS AND STUB UP 1/2" C. TO 6" ABOVE THE CEILING.
- L. COORDINATE EXACT LOCATIONS AND CONTROL REQUIREMENTS OF NEW HVAC EQUIPMENT WITH MECHANICAL CONTRACTOR. IF EQUIPMENT WITH ELECTRICAL REQUIREMENTS OTHER THAN INDICATED IS PROVIDED, IT SHALL BE THE CONTRACTOR'S RESPONSIBILITY TO COORDINATE AND MODIFY THE ASSOCIATED ELECTRICAL EQUIPMENT (CIRCUIT BREAKERS, FUSES, DISCONNECTS, WIRING, CONDUIT, ETC.) TO ACCOMMODATE THE INSTALLATION. ALL REQUIRED MODIFICATIONS SHALL COMPLY WITH THE REQUIREMENTS OF THE NATIONAL ELECTRICAL CODE (NEC).
- M. TELEPHONE, DATA, COMBINATION TELEPHONE/DATA, CABLE T.V. AND AUDIO/VIDEO OUTLETS SHALL EACH CONSIST OF (1) TWO-GANG SQUARE BOX WITH SINGLE GANG ADAPTER TRIM RING AND (1) 3/4" CONDUIT STUBBED UP TO 6" ABOVE AN ACCESSIBLE CEILING. ALL COMMUNICATION CONDUITS SHALL BE INSTALLED WITH INSULATED THROAT BUSHINGS AT EACH END. ALL TELEPHONE, DATA, CABLE T.V. AND AUDIO/VIDEO WIRING, DEVICES AND TERMINATIONS INSTALLED BY OTHERS (OWNER'S VENDOR).


# KEYED NOTES:

- 1) EXISTING PANEL "A" (208v) TO REMAIN.
- 2 EXISTING PANEL "B" (208v) TO REMAIN.
- 3 NO WORK IN THIS AREA.
- (4) EXISTING POWER POLE, METER BASE AND OVERHEAD SERVICE TO REMAIN AS EXISTING.
- (5) EXISTING LIGHT FIXTURES TO REMAIN FOR ILLUMINATION OF MEZZANINE LEVEL.
- 6 EXISTING RECEPTACLE TO REMAIN AS EXISTING.
- 7 EXISTING CEILING MOUNTED SPEAKER TO BE RELOCATED (SEE NOTE #10).
- 8 EXISTING SWITCH SERVING WAREHOUSE LIGHTING TO BE RELOCATED (SEE NOTE #9).
- 9 EXISTING RELOCATED SWITCH. EXTEND AND RECONNECT ALL FROM PREVIOUS LOCATION FOR OPERATION AS EXISTING.
- (10) EXISTING RELOCATED SPEAKER. EXTEND AND RECONNECT ALL FROM PREVIOUS LOCATION FOR OPERATION AS EXISTING.
- SURFACE MOUNT J-BOX TO SERVE POWER CONNECTIONS TO NEW WALL HEATER. NEW SURFACE MOUNTED WALL HEATER SHALL BE EQUAL TO MARKEL NO. E3313TRPW (1500W, 120V). PROVIDE WITH A MARKEL NO. 3310EX33WR SURFACE MOUNTING FRAME. MOUNT HEATER A MINIMUM OF 12" A.F.F. TO HEATER BOTTOM.
- EXISTING DOUBLE DUPLEX RECEPTACLE AND CONDUIT/WIRING TO BE REMOVED. REWORK/EXTEND EXISTING CIRCUIT AS REQUIRED THAT IS SERVING RECEPTACLES DOWNSTREAM TO REMAIN. VERIFY EXACT REQUIREMENTS AT JOBSITE.
- (13) EXISTING MECHANICAL EQUIPMENT AND ASSOCIATED ELECTRICAL TO BE REMOVED BY OWNER.

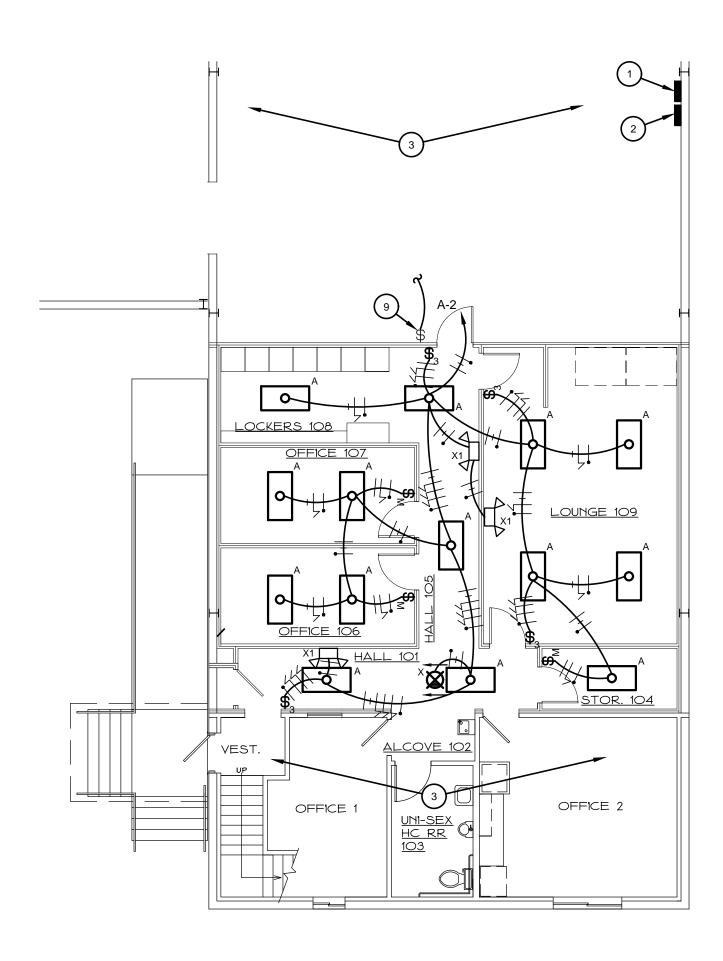

PARTIAL GROUND FLOOR PLAN - LIGHTING



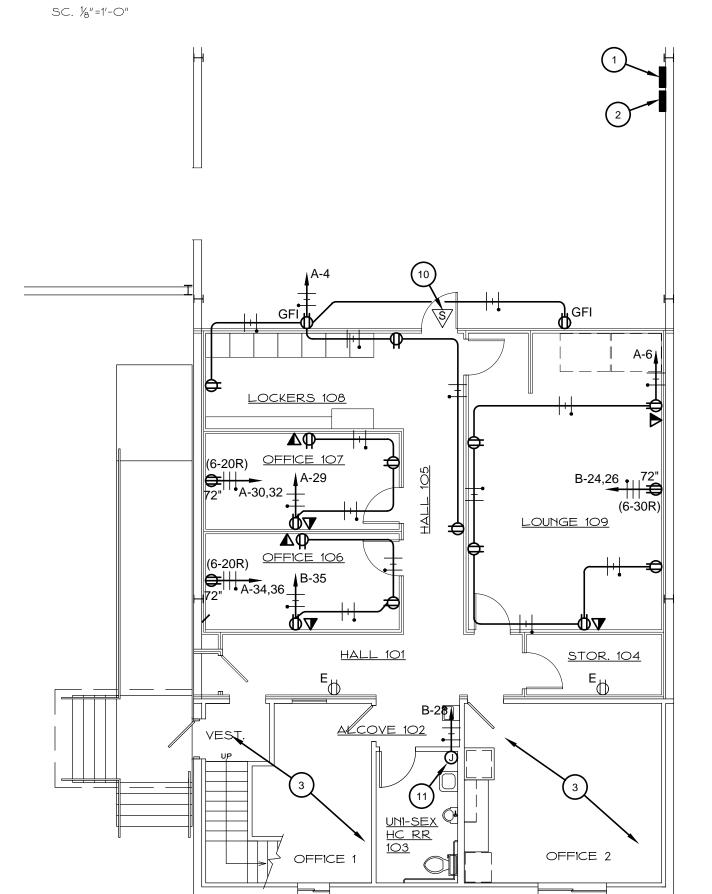

PARTIAL GROUND FLOOR PLAN - POWER & COMMUNICATIONS

SC. 1/8"=1'-0"



TESKE ARCHITECTS 1000 N. TURNER HOBBS, NEW MEXICO PHONE # (575)393-0960

Electrical & Mechanica Consulting Engineers
14302 Slide Road Lubbock, TX 79424-6655
PLI C Progress 78067807475


Consulting Engineers, PLLC
Fax: 806.

Example 14302 8


Lubbock
Fax: 806.

TEXAS FIRM REGISTRATION NO. F-4415

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PUBLIC WORKS FACILITY
REMODEL for
CITY OF LOVINGTON
LOVINGTON, NEW MEXICO

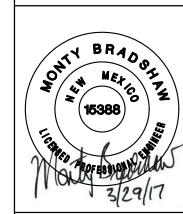


CHECKED BY: MDB
DATE: 3-29-17
SHEET TITLE

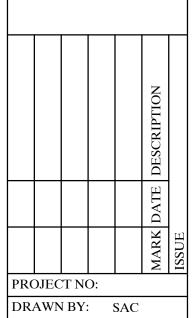PARTIAL ELECTRICAL FLOOR PLANS

E-101

NOTE: UNLESS OTHERWISE INDICATED ON THE DRAWINGS, ALL CONDUCTORS AND CONDUIT SHALL BE SIZED FROM THIS CHART. (\*) INDICATES NUMBER OF PARALLEL SETS

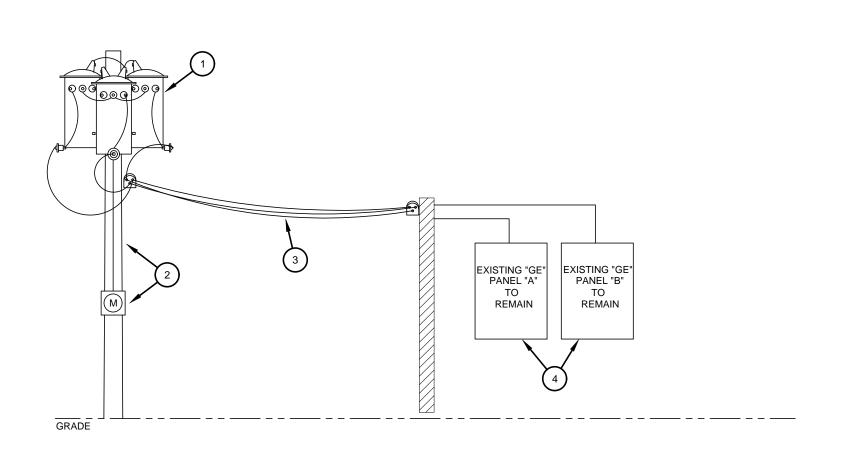

# ELECTRICAL RISER DIAGRAM

NO SCALE

## **KEYED NOTES:**

(1) EXISTING POLE MOUNTED 208V/3Ø TRANSFORMER BANK TO REMAIN AS EXISTING.

2 EXISTING SECONDARY POLE AND METER BASE TO REMAIN.

(3) EXISTING OVERHEAD CONDUCTORS TO REMAIN.

4 EXISTING PANEL, FEEDERS, BRANCH CIRCUITS AND CIRCUIT BREAKERS TO REMAIN AS EXISTING. INSTALL NEW CIRCUIT BREAKERS IN AVAILABLE OPEN SPACES AS SCHEDULED.

## FAULT CALCULATION:

EXISTING 75KVA TRANSFORMER BANK @ 1.5% IMPEDANCE 75K / (208 X1.73205) = 208/1.5% = 13,889 AIC EXISTING SERVICE ENTRANCE & SWITCHBOARD ARE RATED AT 22 KAIC

# LOAD SUMMARY:

1. MOUNT FIXTURE AT 8'-0" AFF TO FIXTURE BOTTOM OR AS DIRECTED BY ARCHITECT.


EXISTING PEAK SUMMER DEMAND LOAD AS MEASURED BY THE UTILITY COMPANY WAS 56KW = 156 AMPS.

EXISTING SERVICE ENTRANCE EQUIPMENT AND MAINS ARE RATED AT 200 AMPS


NOTE: VERIFY ALL PANEL CONDITIONS PRIOR TO BID AND INCLUDE ALL LABOR AND MATERIALS NECESSARY FOR A COMPLETE OPERATION.


LIGHT	ING FIX	XTURE SCHE	DULE - LOVII	NGTON WATER DEPARTMENT									
TYPE	TYPE VOLTS MOUNTING MANUFACTURER CATALOG NUMBER LAMPS NOTES												
Α	120	SURFACE	TEXAS LED	207-A-248L-S32W3450L-DMV-35K	LED								
Х	120	UNIVERSAL	EELP	CA-2-R-WW-EM	LED								
X1	120	WALL	EELP	OEM-LED	LED	1							
LIGHTING	FIXTURE N	IOTES:											

<b>MOUNTING</b> 208/120			SE 4 W		STING R.	PA	NEI	L "A"	MIN. C	M KT. BKF	AINS BUS R. I.C.		MCB (22KAIC) AMPS. AMPS.
DESCRIPTION	LOA	AD / PHA	ASE	BKR	CKT	NO <sup>-</sup>	TES	CKT	BKR	LOA	D/PHA	\SE	DESCRIPTION
	Α	В	С	1	NO.			NO.		Α	В	С	
	2400				1		2	2	20	1050			LIGHTING
EXISTING LOAD		2400		60	3	1	2	4	20		1000		RECEPTACLE
			2400	] [	5		2	6	20			1000	RECEPTACLE
	5000				7			8		2000			
EXISTING LOAD		5000		100	9	1	1	10	70		2000		EXISTING LOAD
			5000	] [	11			12				2000	
	500				13			14		750			
EXISTING LOAD		500		20	15	1	1	16	20		750		EXISTING LOAD
			500		17			18				750	
	1500				19			20		700			
EXISTING LOAD		1500		50	21	1	1	22	20		700		EXISTING LOAD
			1500		23			24				700	
EXISTING LOAD	500			20	25	1	1	26	20	500			EXISTING LOAD
EXISTING LOAD		500		20	27	1	1	28	20		500		EXISTING LOAD
RECEPTACLE			600	20	29	2	•	30	20			2028	TVAZLLO
EVICTING LOAD	700			20	31	1	2	32	7 20	2028			TWU-2
EXISTING LOAD		700		30	33	1		34	20		2028		TVAZLLO
EXICTING LOAD			600	20	35		2	36	7 20			2028	TWU-2
EXISTING LOAD	600			20	37	1		38	30	1250			EVICTING CDADE
EXISTING LOAD		500		20	39	1		40	7 30		1250		EXISTING SPARE
EXISTING LOAD			500	20	41	1	1	42	20			500	EXISTING LOAD
CONNECTED	LOAD:	58,912						DEMAN	D LOAD:	58,912			
PH	IASE A:	194	478	AMPS	162			Р	HASE A:	194	<b>1</b> 78	AMPS	162
	IASE B:		328	AMPS	161				HASE B:	19328 <b>A</b>		AMPS	161
	ASE C:	201	106	AMPS	168			Р	HASE C:	201	106	AMPS	168
<b>GENERAL NOTES:</b> A. ALL 120V SINGL		SE BRAI	NCH CIF	RCUITS S	SHALL BE	E PRO	OVIDE	ED WITH	I A DEDIC	CATED	NEUTRA	L.	
NOTES: 1. EXISTING CIRC 2. PROVIDE/INSTA								N SPACI	Ε.				

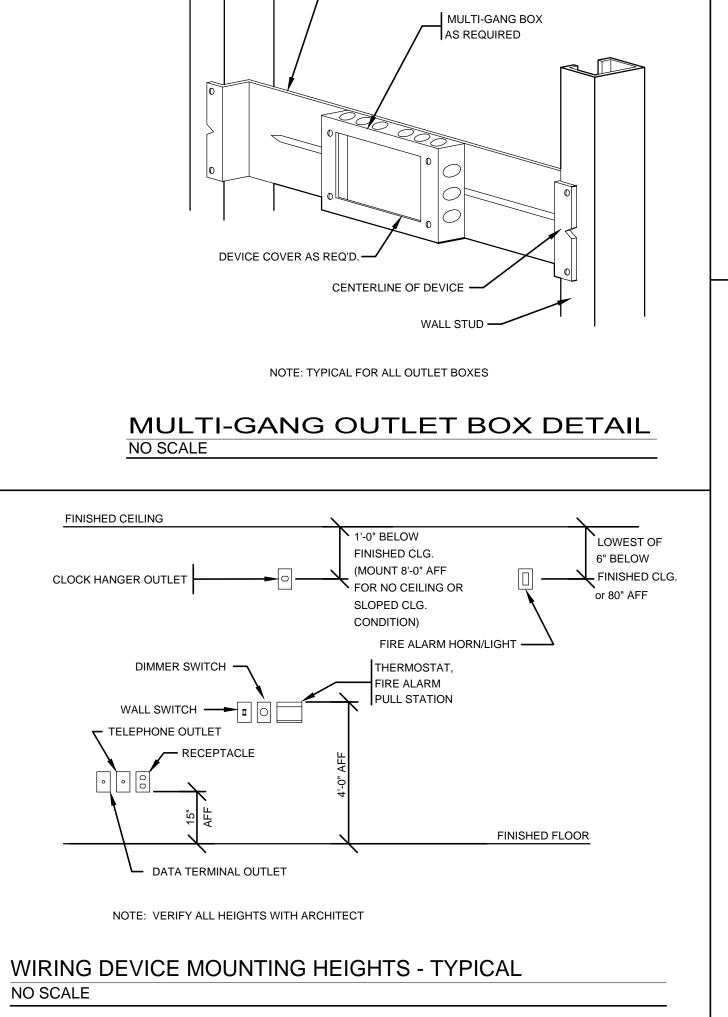

BOX SUPPORT CADDY OR EQUAL

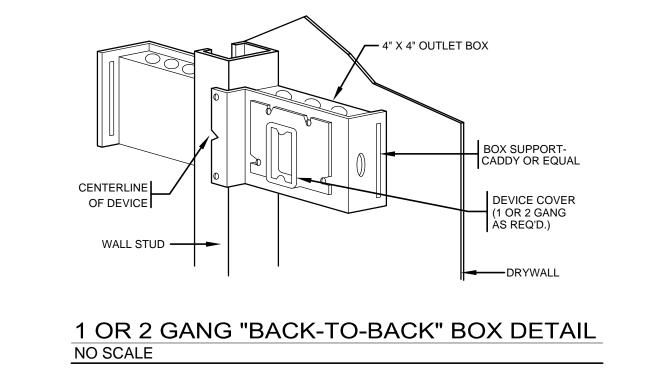

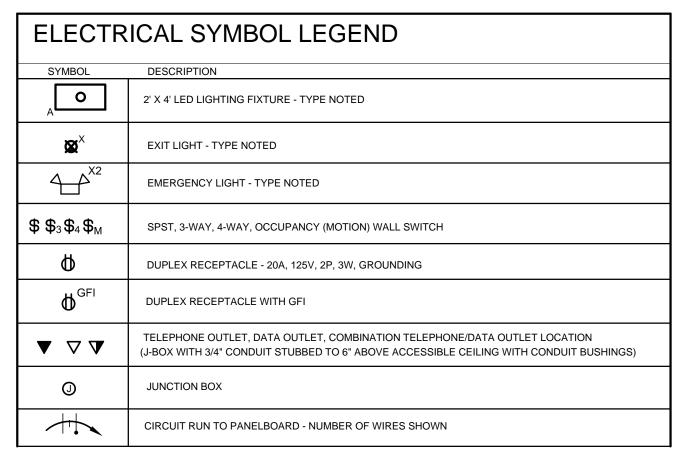

SYMBOL	DESCRIPTION
A	2' X 4' LED LIGHTING FIXTURE - TYPE NOTED
<b>⊠</b> <sup>X</sup>	EXIT LIGHT - TYPE NOTED
<b>∆</b> X2	EMERGENCY LIGHT - TYPE NOTED
<b>5</b> \$ <sub>3</sub> \$ <sub>4</sub> \$ <sub>M</sub>	SPST, 3-WAY, 4-WAY, OCCUPANCY (MOTION) WALL SWITCH
Ф	DUPLEX RECEPTACLE - 20A, 125V, 2P, 3W, GROUNDING
<b>₲</b> <sup>GFI</sup>	DUPLEX RECEPTACLE WITH GFI
▼ ▽ ▼	TELEPHONE OUTLET, DATA OUTLET, COMBINATION TELEPHONE/DATA OUTLET LOCATION (J-BOX WITH 3/4" CONDUIT STUBBED TO 6" ABOVE ACCESSIBLE CEILING WITH CONDUIT BUSHINGS)
<b>o</b>	JUNCTION BOX
	CIRCUIT RUN TO PANELBOARD - NUMBER OF WIRES SHOWN


CONNECTED Ph	IASE A:		070	AMPS	142				D LOAD: HASE A:		070	AMPS	142	
EXISTING LOAD	LOAD	40.040	500	20	41	1		42 DEM A NI	20	40.040			SPACE	
EXISTING LOAD		500		20	39	1	1	40	20		500		EXISTING LOAD	
	500				37		1	38	20	500			EXISTING LOAD	
RECEPTACLE			600	20	35	2	1	36	20			400	EXISTING LOAD	
EXISTING SPARE				60	31 33			32 34	60				EXISTING SPARE	
			800		29			30	]			838888888888888888888888888888888888888		
EXISTING LOAD		800		20	27	1	2	28	20		1500		ELEC.HEATER	
	800				25		2	26	30	2870			EXISTING LOAD  EXISTING LOAD  TWU-1	
		. 555	1000	-	23	'   		24	1			2870		
EXISTING LOAD	1000	1000		20	21	1	1	22	15	400	400			
	1000		750		17 19			18 20		400		500		
EXISTING LOAD		750	750	20	15	1	1	16	20		500	500		
	750				13			14		500				
			2000		11			12				1500		
EXISTING LOAD		2000		70	9	1	1	10	60		1500		EXISTING LOAD	
	2000				7			8		1500				
			5000		5			6	1			1250	100	
EXISTING LOAD		5000		100	3	1	1	4	20		1250		EXISTING LOAD	
	5000				1		П	2		1250		_		
, 2001 til 11011	A	В	С		NO.		0	NO.		Α	В	С	52001 1101V	
ESCRIPTION	10/	AD / PHA	N Q E	BKR	CKT NOTES CKT				BKR LOAD / PHA					
<u>208/120</u>	VOLTS	3 PHA	SE 4 W	/IRE + G	R.				MIN. C	KT. BKF	BUS R. I.C.		AMPS.	
MOUNTING	SURFA	CE		EXIS	STING	PA	NEL	<u> "B"</u>		M	AINS	200A	MCB (22KAIC)	


A. ALL 120V SINGLE PHASE BRANCH CIRCUITS SHALL BE PROVIDED WITH A DEDICATED NEUTRAL.

1. EXISTING CIRCUIT BREAKER/LOAD TO REMAIN AS EXISTING.

2. PROVIDE/INSTALL NEW CIRCUIT BREAKER IN AVAILABLE OPEN SPACE.

TESKE ARCHITECTS 1000 N. TURNER HOBBS, NEW MEXICO PHONE # (575)393-0960

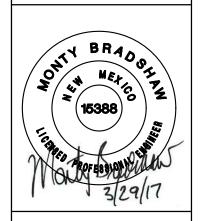

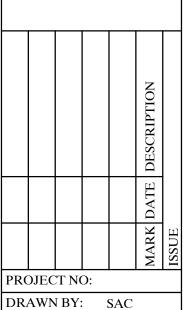

CHECKED BY: MDB DATE: SHEET TITLE

ELECTRICAL RISER DIAGRAM, PANEL SCHEDULES, SYMBOL LEGEND AND DETAILS